CONDITIONAL USE PERMIT PLAN – FOR ––––––

REFERENCES

♦ OVERALL DEVELOPMENT PLAN: URBAN, LTD "MAJOR SITE PLAN FOR THE GARRISON AT STAFFORD" 4200 D TECHNOLOGY COURT CHANTILLY, VA 20151 CONTACT: CLAYTON TOCK, P.E

* THE ABOVE REFERENCED DOCUMENTS AR INCORPORATED BY REFERENCE AS PART OF THESE PLANS, HOWEVER, BOHLER ENGINEERING DOES NOT CERTIEY THE ACCURACY OF THE WORK REFERENCED OR DERIVED FROM THESE DOCUMENTS, BY OTHERS.

GENERAL NOTE: T IS THE RESPONSIBILITY OF THE CONTRACTOR TO REVIEW ALL OF THE DRAWINGS AND SPECIFICATIONS ASSOCIATED WITH THIS PROJECT ORK SCOPE PRIOR TO THE INITIATION OF CONSTRUCTION. SHOULD THE CONTRACTOR FIND A CONFLICT WITH THE DOCUMENTS RELATIVE TO


E SPECIFICATIONS OR APPLICABLE CODES, IT IS THE CONTRACTOR'S RESPONSIBILITY TO NOTIFY THE PROJECT ENGINEER OF RECORD IN RITING PRIOR TO THE START OF CONSTRUCTION. FAILURE BY THE CONTRACTOR'S RUSTING PRIOR TO NOTIFY THE PROJECT ENGINEER SHALL CONSTITUTE

YTANCE OF FULL RESPONSIBILITY BY THE CONTRACTOR TO COMPLETE THE SCOPE OF THE WORK AS DEFINED BY THE DRAWINGS ANI

RAISING CANES #C0970

PROPOSED

LOCATION OF SITE **425 GARRISONVILLE ROAD STAFFORD, VA 22556 GARRISONVILLE ELECTION DISTRICT** TM: 20AC-1-1

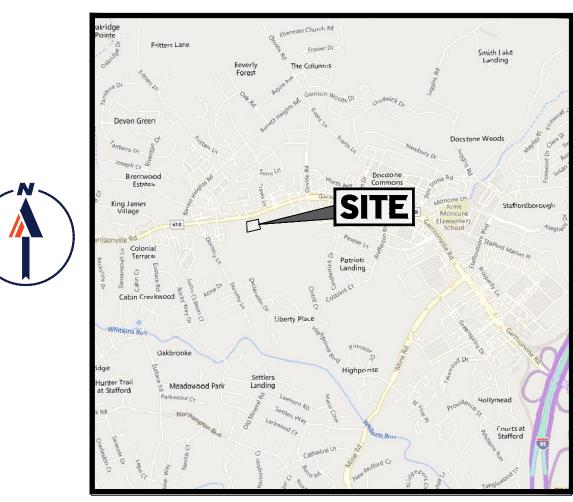

LOCATION MAP SCALE: 1" = 2,000 PLAN REFERENCE: MICROSOFT CORPORATION

OWNER ROUTE 606- RESTON LLC

11708 BOWMAN GREEN DR RESTON VA 20190-3501

APPLICANT/DEVELOPER RAISING CANES RESTAURANTS, LLC

6800 BISHOP ROAD PLANO, TEXAS 75024-4274 DEVELOPER CONTACT: ADAM CARACCI DEVELOPER EMAIL: ACARACCI@RAISINGCANES.COM

PREPARED BY



CONTACT: BRIAN MILLER P.E. 9100 ARBORETUM PKWY, SUITE 140 RICHMOND, VA 23236 PHONE: (804) 893-8200


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OVER SHEET	C-100
EGEND	C-101
ONDITIONAL USE PERMIT PLAN	C-300

MT		SITE CIVIL AND CONSULTING ENGINEERING LAND SURVEYING PROGRAM MANAGEMENT LANDSCAPE ARCHITECTURE SUSTAINABLE DESIGN PERMITTING SERVICES TRANSPORTATION SERVICES	THE INFORMATION DESIGN AND CONTENT OF THIS PLAN ARE PROPRETARY AND SHALL NOT BE COPIED OR USED FOR ANY PURPOSE WITHOUT PRIOR WRITTEN AUTHORZATION FROM BOHLER, ONLY APPROVED, SIGNED AND SEALED PLANS SHALL BE UTILIZED FOR CONSTRUCTION PURPOSES © BOHLER
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BOHLER// 9100 ARBORETUM PKWY, SUITE 140 RICHMOND, VIRGINIA 23236 Phone: (804) 893-8200 VA@BohlerEng.com			
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SHEET TITLE:			
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	ORG	. DATE - 03/17/2023	

STANDARD DRAWING FOR ENTIRE PLAN SET		LEGEND	A	STANDARD BBREVIATIONS	
LIMIT OF WOR		LOWLOW		FOR ENTIRE PLAN SET	
LIMIT OF DIST		LODLOD	AC	ACRES AMERICANS WITH	
		 T	ADA	DISABILITY ACT	
EXISTING NOTE	TYPICAL NOTE TEXT	PROPOSED NOTE	ARCH BC	ARCHITECTURAL BOTTOM OF CURB	
			BF	BASEMENT FLOOR	
	LINE / R.O.W. LINE NEIGHBORING		ВК	BLOCK	
	 PROPERTY LINE / INTERIOR PARCEL LINE 		BL	BASELINE	
	_ EASEMENT		BLDG	BUILDING	
			BM BRL	BUILDING BENCHMARK	
	_ SETBACK LINE		CF		
			CL	CENTERLINE	
			CMP	CORRUGATED METAL PIPE	
		CURB AND GUTTER	CONN		
	CONCRETE CURB &	SPILL TRANSITION	CONC CPP	CONCRETE CORRUGATED PLASTIC PIPE	
	GUTTER	DEPRESSED CURB AND GUTTER	CY	CUBIC YARDS	
			DEC	DECORATIVE	
O	UTILITY POLE WITH LIGHT		DEP	DEPRESSED	
	POLE				
0	LIGHT		DOM ELEC		
D	TRAFFIC LIGHT		ELEC	ELEVATION	
0	UTILITY	\sim	EP	EDGE OF PAVEMENT	
	POLE	0	ES	EDGE OF SHOULDER	
	TYPICAL LIGHT		EW		
¢	ACORN	ф	EX FES	EXISTING FLARED END SECTION	
~~	LIGHT	~~ 	FES FF	FINISHED FLOOR	
	TYPICAL SIGN		FH	FIRE HYDRANT	
\wedge	PARKING	\land	FG	FINISHED GRADE	
<u>/ ^ </u>	COUNTS		G		
			GF	GARAGE FLOOR (AT DOOR)	
<i></i>	- CONTOUR	190	GL	GRADE LOWER SIDE OF WALL	
169	– LINE	187	GRT	GRATE	
TC 516.4 OR 516.4	SPOT ELEVATIONS	TC 516.00 TC 516.00 MATCH EX BC 515.55 (518.02 ±)	GV	GATE VALVE	
		•••••••••••••••••••••••••••••••••••••••	HDPE	HIGH DENSITY POLYETHYLENE PIPE	
			HP	HIGH POINT	
SAN #	SANITARY LABEL	SAN #	HOR	HORIZONTAL	
\overline{X}	STORM	X #	HW	HEADWALL	
	LABEL	#	INT		
SL	SANITARY SEWER LATERAL	SL	INV LF	LINEAR FOOT	
W			LOC	LIMITS OF CLEARING	
			LOD	LIMITS OF DISTURBANCE	
E	_ UNDERGROUND ELECTRIC LINE	E	LOS	LINE OF SIGHT	
	_ UNDERGROUND GAS LINE	G	LP L/S	LOW POINT	
<u></u>	OVERHEAD		L/S MAX	MAXIMUM	
OH	_ OVERHEAD WIRE	ОН	MIN	MINIMUM	
Γ	UNDERGROUND	TT	МН	MANHOLE	
^	_ UNDERGROUND	C	- MJ		
	CABLE LINE		OC PA	ON CENTER POINT OF ANALYSIS	
= = = = = = = =	- STORM - SEWER		PA PC	POINT OF ANALYSIS	
<i>S</i>	- SANITARY	ss	PCCR	POINT OF COMPOUND	
: <u> </u>	SEWER MAIN				
V	HYDRANT	V	PI POG	POINT OF INTERSECTION	
(S)	SANITARY		PROP	PROPOSED	
<u> </u>	MANHOLE		PT	POINT OF TANGENCY	
\bigcirc	STORM MANHOLE		PTCR	POINT OF TANGENCY, CURB RETURN	
⊗ ^{WM}	WATER	0	PVC	POLYVINYL CHLORIDE PIPE	
WV	METER		PVI	POINT OF VERTICAL	
\bowtie	WATER VALVE		PVT	NTERSECTION POINT OF VERTICAL TANGENO	
	GAS		R	RADIUS	
	VALVE		RCP	REINFORCED CONCRETE PIPE	
	GAS METER		RET WALL		
	TYPICAL END		R/W S	RIGHT OF WAY	
- 	SECTION	- 	S SAN	SANITARY SEWER	
OR	HEADWALL OR ENDWALL		SF	SQUARE FEET	
	GRATE INLET		STA	STATION	
	CURB		- STM	STORM	
	INLET	<u>©</u>	S/W		
0	CLEAN OUT	0	TBA TBR	TO BE ABANDONED	
	ELECTRIC	· · · · · · · · · · · · · · · · · · ·	TBR	TO BE RELOCATED	
(E)	MANHOLE	Ē	TBV	TO BE VACATED	
(T)	TELEPHONE MANHOLE	(T)	тс	TOP OF CURB	
	ELECTRIC		TELE	TELEPHONE	
EB	BOX	EB	TPF TW	TREE PROTECTION FENCE	
EP	ELECTRIC PEDESTAL	EP	TYP	TYPICAL	
		1	UG	UNDERGROUND	
		1	UP	UTILITY POLE	
\bigcirc	MONITORING WELL	\bigcirc	W	WIDE	
\bigcirc		┤	W/L	WATER LINE	
<u> </u>	TEST	┤ ₽ ₽			
	TEST PIT		W/M		
			W/M ± °	VATER METER PLUS OR MINUS DEGREE	


PROPOSED EASEMENT LEGEND				
	COMMON SHARED			
Ê ⊟	INGRESS-EGRESS			
	PUBLIC ACCESS			
	PUBLIC UTILITY			
SAN	SANITARY SEWER			
SI	SIGHT DISTANCE			
STM	STORM DRAIN			
VAR	VARIABLE WIDTHS			
W DIM	WATER			

MT		SITE CIVIL AND CONSULTING ENGINEERING LAND SURVEYING PROGRAM MANAGEMENT LANDSCAPE ARCHITECTURE SUSTAINABLE DESIGN PERMITTING SERVICES TRANSPORTATION SERVICES	THE INFORMATION, DESIGN AND CONTENT OF THIS PLAN ARE PROPRIETARY AND SHALL NOT BE COPIED OR USED FOR ANY PURPOSE AUTHORIZATION FROM BOHLER, ONLY APPROVED SIGNED AND SEALED PLANS SHALL BE UTILIZED FOR CONSTRUCTION PURPOSES © BOHLER	
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	PURF	R CONCEPT POSES ONLY		
THIS DRAWING IS INTENDED FOR MUNICIPAL AND/OR AGENCY REVIEW AND APPROVAL. IT IS NOT INTENDED AS A CONSTRUCTION DOCUMENT UNLESS INDICATED OTHERWISE. PROJECT No.: VAC220058.02 DRAWN BY: PCM CHECKED BY: BBM DATE: 03/17/2023 CAD I.D.: SITE				
PROJECT: CONDITIONAL USE PERMIT PLAN				
FOR Raising LHICKEN FINGERS PROPOSED RAISING CANES #C0970 425 GARRISONVILLE ROAD STAFFORD, VA 22556 GARRISONVILLE ELECTION DISTRICT				
BOHLER // 9100 ARBORETUM PKWY, SUITE 140 RICHMOND, VIRGINIA 23236 Phone: (804) 893-8200 VA@BohlerEng.com				
SHEET TITLE:				
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HATCH LEGEND

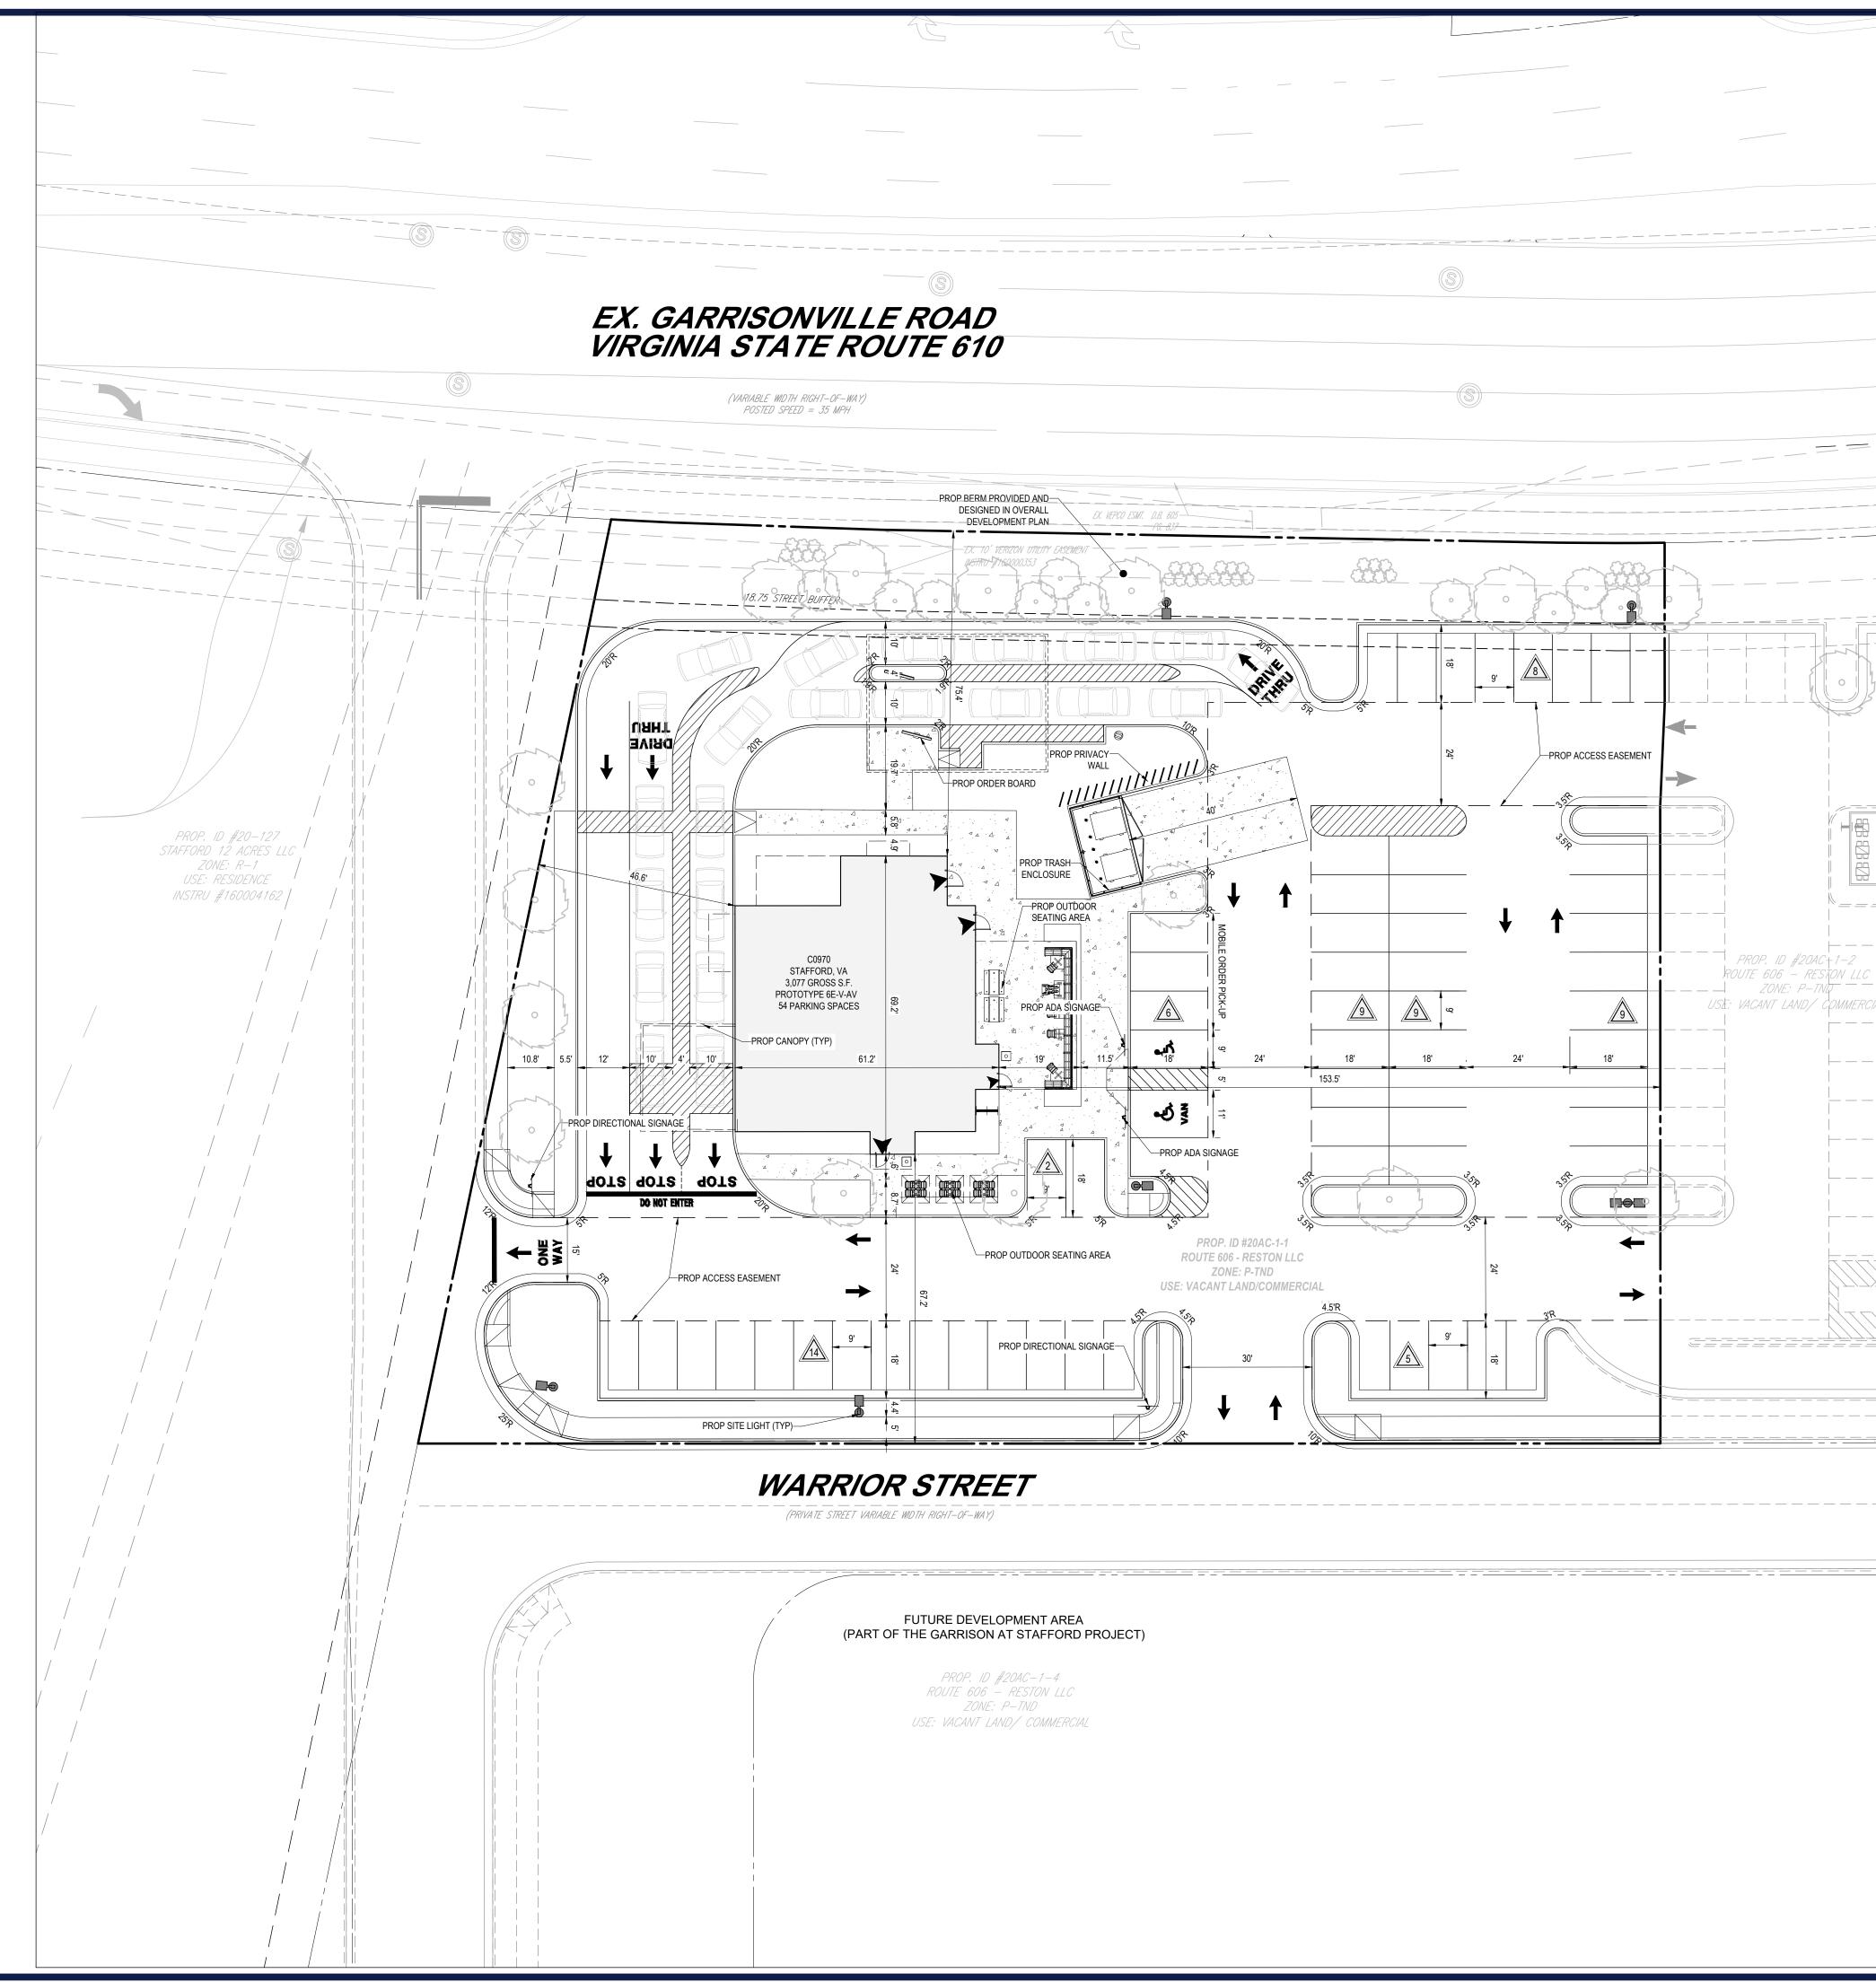

VEMENT & STRIPING	PROP BUILDING (SEE ARCH DRAWINGS)
]	
WALK CRETE	ASPHALT PAVEMEI

LEGEND

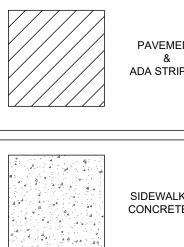--

PROPOSED CONDITIONAL USE PERMIT AREA/ PROPERTY LINE .

CUP NOTES

- 1. THIS GDP HAS NOT BEEN REVIEWED FOR FULL COMPLIANCE WITH THE STAFFORD COUNTY ORDINANCE AT THIS TIME. ALL PROPOSED SITE IMPROVEMENTS SHOWN ON THIS PLAN MAY BE AMENDED BY THE OWNERS TO FULFILL REQUIREMENTS OF FINAL ENGINEERING, OR COMPLIANCE WITH CURRENT STATE AGENCY REGULATIONS AND/OR COUNTY DEVELOPMENT REGULATIONS / STANDARDS IN PLACE AT THE TIME OF SITE PLAN SUBMISSION.
- 2. ALL PLANTINGS SHOWN ARE FOR CONCEPTUAL PURPOSES ONLY. ALL BUFFER YARDS AND LANDSCAPING WILL BE PROVIDED IN ACCORDANCE WITH CURRENT STAFFORD COUNTY DEVELOPMENT STANDARDS IN PLACE AT THE TIME OF SITE PLAN SUBMISSION.
- 3. ANY EXISTING PUBLIC WATER AND SANITARY SEWER LINES AND APPURTENANCES, THAT WILL BE IN CONFLICT WITH THE PROPOSED IMPROVEMENTS/PERMANENT STRUCTURES, SHALL BE RELOCATED. ADDITIONALLY, ANY RELATED EASEMENTS WILL BE VACATED AND REDEDICATED.
- 4. THE PROPOSED RAISING CANES WITH DRIVE THRU BUILDING IS 3,077 GSF± WITH 1 STORY AND A BUILDING HEIGHT OF 25 FEET. THERE ARE 22 PROPOSED STACKING SPACES WITHIN THE CONDITIONAL USE PERMIT LIMITS. THE CONDITIONAL USE PERMIT AREA IS \pm 56,256 SF = 1.29 AC.
- 5. SITE 20-AC-1-1 IS WITHIN THE OVERALL DEVELOPMENT "THE GARRISON AT STAFFORD" PROJECT BEING DEVELOPED BY THE PENCE GROUP.
- 6. CODE COMPLIANT LANDSCAPE, SCREENING BERM, AND SIGNAGE DESIGNED AND PROVIDED BY OVERALL DEVELOPMENT PLAN REFERENCED ABOVE.

ZONING INFORMATION AND NOTES:

ZONE: USE: OVERLAY:	PTND - PLANNED-TRADITIONAL NEIGHBORHOOD FAST FOOD RESTAURANT WITH DRIVE-THRU FACILITY HIGHWAY CORRIDOR OVERLAY DISTRICT			
BULK REQUIREMENT	-S:	REQUIRED	PROPOSED	
BUILDING FAR		0.7 MAX	0.05	
MIN. BUILDING SETB.	ACK			
	SIDE SETBACK (EAST)	0'	153.5'±	
	FRONT SETBACK (NORTH)	18.75'	75.4'±	
	REAR SETBACK (SOUTH)	0'	67.2'±	
	SIDE SETBACK (WEST)	0'	46.6'±	
PARKING REQUIREM				
	11 SPACES / 1,000 GFA	34	54	
11	SPACES X 3.077 = 34 SPACES			
	ACCESSIBLE SPACES	3	2	
	STACKING SPACES		15+7 EXPO	
MAX. BUILDING HEIG	60'*	25'±		
OPEN SPACE RATIO		0.25	0.28	
* PER REZONING DO	DCUMENTS FOR RC21153747			

1"= 20'

